


ZONING SCHEDULE

R-40 -RESIDENTIAL	REQUIRED	PROPOSED	VARIANCE
MIN LOT AREA (SF)	40,000	7,758	N
MIN LOT WIDTH (FT)	150	50	N
MAX BUILDING HEIGHT (FT)	35	<i>35</i>	N
STORIES	2.5	2	N
MIN YARD DIMENSIONS (FT)			
FRONT	50	50	N
SIDE (WIDTH 70 OR LESS)	<i>7.5</i>	<i>7.5</i>	N
REAR	30	53.1	N
MAX BUILDING COVERAGE (SF)	1260	1,250.75	N
MAX FLOOR AREA (SF)	1750	2,362.75	Y 612.75
MIN LANDSCAPE COVERAGE (SF)	4200	4515	N
ACCESSORY BUILDINGS		OT APPLICABLE	/•

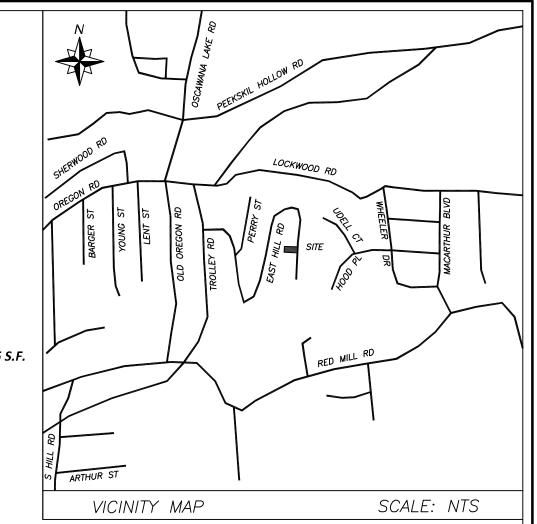


First floor: 850.75 sf Second Floor: 1,112 sf Garage: 400 sf

Building coverage: =1,250.75 sf

BUILDING HEIGHT CALCULATION TABLE

GRADE																		
	Α	A1	A2	В	B1	B2	С	C1	C2	D	D1	D2	Ε	E1	E2	F	F1	Τ
AT HOUSE	308.2			303.6			300.4			299.8			306.2			308.1		
20' OFFSET		309.7	309.2		304.7	299.9		301.9	296.7		296.2	298.6		305.9	308.1		306.7	T
AVERAGE GRADE		309	0.45		302	2.3		299	9.8		29	77.4		30	7.0		30	7.
								AV/ED/	NOT TIMEL									
									AGE FINISH HED FLOOF				<i>30.</i> <i>30.</i>	3.8 9.0				
								FINIS		₹				9.0				_
								FINISI GARA	HED FLOOF	?			30	9.0 7.0				_

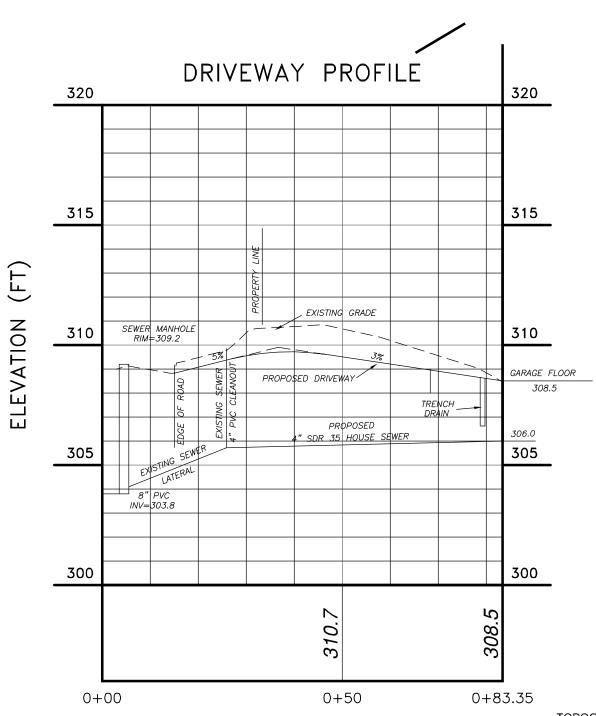

FIRST FLOOR AVERAGE GRADE 303.7 BASEMENT FLOOR

PROFILE SCALE:
HORIZ: 1"=20'
VERT: 1"=4'

TOPOGRAPHIC SURVEY PREPARED BY LINK LAND SURVEYORS, DATED DECEMBER 19, 2022. DATUM IS NAVD 1988

THERE ARE NO WATERCOURSES. PONDS, LAKES AND WETLANDS WITHIN 200 FEET OF THE PROPERTY LINE EXCEPT AS SHOWN ON THESE PLANS THERE ARE NO EXISTING OR PROPOSED WELLS OR SEPTIC SYSTEMS WITHIN 200 FEET OF THE PROPERTY LINES EXCEPT AS SHOWN ON THESE PLANS.

ALTERATION OF THIS DRAWING EXCEPT BY A LICENSED P.E. OR ARCHITECT OR LICENSED LAND SURVEYOR IS ILLEGAL. ANY ALTERATION BY A P.E. OR ARCHITECT OR SURVEYOR MUST BE INDICATED AND BEAR HIS SEAL SIGNATURE AND DATE OF ALTERATION.



2	JAN. 17, 2023	BULK TABLE RE	EVISED				
1	JAN. 10, 2023	BULK TABLE &	TREE TAGS R	EVISED			
	كال	HN	KA	RELL,	JR.	P.E.	
		12	21 CUS	HMAN ROA	D		
		PATTE	RSON	NEW YORK	12563	845-878-7894 phone	:

	PATTERSON, NEW YORK	12503	845-878-4939 fax jack4911@yahoo.com
OWNER:	MJD CONSTRUCTION	SCALE:	LATEST REVISION:
	47 EAST HILL ROAD	1" =10'	
	CORTLANDT (T)	DATED:	SHEET No.
	SITE PLAN	DECEMBER 27, 2022 TAX MAP:	_ S-1
	SHEFLAN	 13.10-1-33	



NOTES:

1. TM # 13.10-1-33

LOT AREA = 7,758 Sq.Ft. - 0.1781 ACRE

TOPOGRAPHIC INFORMATION BY LINK LAND SURVEYORS, P.C., DATED DECEMBER 19, 2022 DATUM NAVD 1988

4. THE CONTRACTOR WILL OBTAIN ALL NECESSARY PERMITS IF BLASTING IS REQUIRED. THE CONTRACTOR IS TO CONTACT THE UNDERGROUND LINES LOCATION SERVICES, CODE 53, PRIOR TO

COMMENCING CONSTRUCTION.

5. RELATIVE TO THE CURB CUT: A. WHEN NECESSARY PERMITTEE IS TO ESTABLISH A WORK ZONE, SUPPLY AND MAINTAIN APPROPRIATE SIGNS, CONES, LIGHTS AND FLAG PEOPLE IN ACCORDANCE WITH SECTION

> 104 OF THE HIGHWAY LAW. ROAD CLOSURES ARE NOT ALLOWED.

C. STONE CURBS ARE THE OWNERS RESPONSIBILITY TO

D. OVERNIGHT OPEN EXCAVATIONS WILL NOT BE PERMITTED. MINIMUM SIGHT DISTANCE IN BOTH DIRECTIONS AT DRIVEWAY

ENTRANCE EXCEEDS 200 FEET. A LIMIT OF DISTURBANCE LINE IS SHOWN ON THE PLANS.

ELECTRIC IS OVERHEAD. 9. NO WETLANDS EXIST ON OR WITHIN 100 FEET OF THIS PROPERTY.

10. THIS ENGINEER HAS REVIEWED THE PROPOSED HOUSE PLANS AND THIS SITE PLAN HAS BEEN COMPLETED REFLECTING SUCH PLANS FOR A 51 x 30 FOOT HOUSE PREPARED BY JOHN KARELL JR.

11. ALL TREES TO BE REMOVED SHALL BE TAGGED BY THE APPLICANT AND INSPECTED BY THE TOWN OF CORTLANDT PRIOR TO CUTTING AND A BUILDING PERMIT BEING ISSUED. 12. ALL PROPOSED OR DISTURBED SLOPES 2:1 OR GREATER WILL BE STABILIZED BY AN EROSION CONTROL BLANKET. IT IS NOT EXPECTED THAT ANY FINAL SLOPES WILL EQUAL OR

EXCEED 2:1. 13. SIGNS, MASONRY, CONCRETE, STONE WALLS, FENCES, BUSHES, PLANTING AND/OR TREES ARE NOT ALLOWED WITHIN THE RIGHT OF WAY. MASONRY/STEEL MAILBOX STRUCTURES WILL NOT BE PERMITTED. WOODEN MAILBOX POSTS ARE RECOMMENDED. A STANDARD U.S.

MAILBOX SHALL BE UTILIZED. 14. SIGNED AND SEALED CALCULATIONS IN ACCORDANCE WITH THE TOWN OF CORTLANDT CODE SECTION 307-04, "HEIGHT (OF BUILDING)" SHALL BE PROVIDED. 15. BEFORE A C.O. IS ISSUED THE TOWN WILL REQUIRE CERTIFICATION FROM THE DESIGN ENGINEER THAT THE PROPOSED WORK WILL NOT ADVERSELY AFFECT SURFACE AND

SUBSURFACE DRAINAGE ON ADJACENT PROPERTIES. 16. THE APPLICANT IS REQUIRED TO CONTACT THE TOWN OF CORTLANDT HIGHWAY DEPARTMENT REGARDING UTILITY PERMITS AND MODULAR HOME TRANSPORT. THE PROPOSED ROUTE OF THE MODULAR HOME MUST BE PROVIDED TO AND APPROVED BY THE TOWN OF CORTLANDT BEFORE A BUILDING PERMIT IS ISSUED.

17. ADDITIONAL INFORMATION, NOTES, ETC. AS DETERMINED BY THE DIRECTOR OF TECHNICAL SERVICES MAY BE REQUIRED IN ACCORDANCE WITH THE TOWN OF CORTLANDT CODE SECTION 307-69, "PROCEDURES FOR MINOR PROPOSALS AND PROPOSALS FOR SINGLE AND TWO FAMILY DWELLINGS". DEVIATIONS FROM THE REQUIREMENTS HEREIN SHALL BE AT THE DISCRETION OF THE TOWN OF CORTLANDT

SEEDING AND MULCHING NOTES

Seeding and mulching of disturbed areas shall be in accordance with the requirements set forth in "New York Standards and Specifications for Erosion and Sediment Control".
2. TEMPORARY SEEDING

Spring, Summer or early Fall Rye grass at 1 lb / 1000 square feet, 30 lbs / acre Late Fall, early Winter

Aroostook winter rye (cereal rye) at 100 lbs / acre, 2.5 lb / 1000 square feet

Use a cultipacker type seeder if possible. Seed to a depth of 1/8 to 1/4 inch. If seed is to be broadcast, cultipack or roll after seeding. If hydroseeded, lime and fertilizer may be applied through the seeder and

LBS/1,000 sq. ft

Seed using the following mix and rates Species (% by weight)

3. PERMANENT SEEDING

65% Kentucky Bluegrass Blend 20% Perennial Ryegrass 15% Fine Fescue

100% Tall Fescue , Turf-type fine leaf

3.4-4.6 When using the cultipacker or broadcast seed method. Mulch using small grain straw, applied at a rate of 2 tons

per acre and anchor with a netting or tackifier. Hydroseed applications should include mulch, fertilizer and seed Sequence of Construction

0.4 - 0.6

A. General Discussion

The following are sequence and methods of construction for the construction of a drainage system on property owned by MJD Construction, 47 East Hill Rd, Cortlandt, New York. Erosion and sediment control measures are ncorporated into the construction program. Construction of this project will be in one phase.

Proposed erosion and sediment control methods are found on the Site Plan. The erosion controls are designed in

The project is expected to start in the Spring of 2023 and continue over a one year period.

B. General Construction Notes

The site shall be disturbed in accordance with the construction sequence. Only the smallest practical area of and shall be exposed at any one time during development. When land is exposed, the exposure shall be kept to the shortest practical period of time by immediate stabilization per the stabilization notes, unless specified otherwise. All disturbed areas that are seeded with appropriate seed mixture and procedure are considered stabilized when 80%

2. Natural vegetation shall be retained and protected.

3. The contractor shall inspect all erosion and sediment control devices during all storm events, prior to weekends and prior to all forecasted storm events.

200.0' SIGHT DISTANCE

4. Work on the drainage system will not be performed during wet periods. The Engineer supervising construction will determine when the installation of the drainage system may proceed.

C. Detailed Construction Sequence

1. Conduct as pre construction meeting at least 48 hours before construction commences. The meeting will include the owner/applicant, engineer, Town

representatives, contractor and the NYCDEP representative. Install all erosion and sediment control measures including silt fencing and

3. Survey locate the house, SSTS, infiltrators and limits of disturbance.

4. Clear, grub and grade for construction of the house, sewer line and driveway. Install the item # 4 driveway.

Seed and mulch all newly disturbed areas.

Begin construct the house. Install utilities, including the sewer line and water line

Seed and mulch all disturbed areas. Install the infiltrators and all associated structures.

Remove the erosion control measures as directed by the Engineer after All disturbed areas are properly vegetated.

MAINTENANCE SCHEDULE **EROSION AND SEDIMENT CONTROL PRACTICES**

CONSTRUCTION ONSET THROUGH STABILIZATION - CONTRACTOR'S RESPONSIBILITY

FREQUENCY REQUIRED WITHIN CONSTRUCTION SEDIMENT IN STONI REPLENISH OR REMOVE STONE 48 HOURS EDIMENT ACCUMULATION DAMAGED OR FALLEN REPAIR. REPLACE DAILY REPAIR, REPLACE WEEKLY 48 HOURS HDPE PIPE DAMAGED OR CLOGGED RIP RAP OUTLET RIP RAP FAILURE, SOIL EROSION REPAIR REPLACE CHANNEL BLOCKAGE REPAIR REPLACE CATCH BASINS SILT ACCUMULATION REMOVE SILT INFILTRATORS RESEED AND MULCH MULCHED AREAS CONSTRUCTION REPAIR REPLACE DAMAGED FALLEN WEEKLY 48 HOURS LONG TERM (AFTER STABILIZATION) - RESPONSIBILITY OWNER

REMEDIATION FREQUENCY REQUIRED WITHIN HDPE PIPE CLOGGING OF DAMAGE REPAIR REMOVE CLOG ANNUALLY ONE WEEK REMOVE INVASIVE SPECIES INVASIVE SPECIES TWICE A YEAR ONE WEEK RAIN GARDENS LATE FALL VEGETATION ANNUALLY

OWNER/APPLICAN Ben Cozzi PO Box 627

Jefferson Valley, NY, 10535 845-628 6288

SPECIAL PROJECT NOTES:

1. FOUNDATION SURVEY TO BE PROVIDED PRIOR TO FRAMING

2. ANY IMPORTED SOIL SHALL MEET THE NYSDEC STANDARDS OF UNRESTRICTED FILL AND SUITABLE FOR RESIDENTIAL USE. CONSTRUCTION DEBRIS IS NOT PERMITTED TO BE IMPORTED. ANY MATERIAL MEETING THE NYSDEC DEFINITION OF BENEFICIAL USE SHALL BE CERTIFIED AS SUCH BY THE DESIGN PROFESSIONAL OF RECORD. NOTIFY THE TOWN OF CORTLANDT PRIOR TO IMPORT. SOIL TESTING MAY STILL BE REQUIRED.

3. PRIOR TO BACKFILLING OF ANY STORM WATER BEST MANAGEMENT PRACTICE, DOTS-ENGINEERING SHALL BE NOTIFIED TO PERFORM AN INSPECTION. CONTACT ENGINEERING AT 914-734-1060 TO SCHEDULE AN

4. PRIOR TO THE ISSUANCE OF A CERTIFICATE OF OCCUPANCY, ENGINEER/ARCHITECT SHALL SUBMIT A CERTIFICATION ADDRESSED TO "THE TOWN OF CORTLANDT DEPARTMENT" OF TECHNICAL SERVICES" THAT THE SITE WORK HAS BEEN COMPLETED IN ACCORDANCE WITH THE APPROVED PLANS ON FILE WITH THE TOWN AND THAT THERE IS NO ADVERSE IMPACTS TO ADJACENT AND ADJOINING NEIGHBORS AS IT PERTAINS TO DRAINAGE AND


5. PRIOR TO ISSUANCE OF A CERTIFICATE OF OCCUPANCY/COMPLIANCE, AN AS-BUILT DETAIL OF ALL RETAINING WALLS SHALL BE SUBMITTED ALONG WITH CERTIFICATION BY THE DESIGN PROFESSIONAL THAT ALL FACTORS OF SAFETY HAVE BEEN IN ACCORDANCE WITH THE APPROVED PLANS ON FILE WITH THE TOWN.

6. THE APPLICANT IS AWARE THAT THE ENTIRE SITE MUST BE 100% STABILIZED PRIOR TO THE ISSUANCE OF A CERTIFICATE OF OCCUPANCY. DISTURBED AREAS SHALL BE RESTORED AND STABILIZED APPROPRIATELY AND IN A TIMELY MANNER. APPLICANT SHALL SUBMIT A NOTICE OF TERMINATION FOR THE SPDES GENERAL PERMIT.

7. PRIOR TO THE ISSUANCE OF A CERTIFICATE OF OCCUPANCY, AN "AS-BUILT" SURVEY PREPARED BY A LICENSED PROFESSIONAL LAND SURVEYOR OF THE PROPERTY SHALL BE SUBMITTED TO THE DEPARTMENT OF TECHNICAL

8. FOOTING DRAINS SHALL BE SDR 35 AND SEPARATE FROM LEADER DRAINS AND DRAIN TO DAYLIGHT

9. NO RECYCLED PRODUCT MAY BE USED ONSITE OR FOR BACKFILLING WATER SERVICE AND UTILITIES

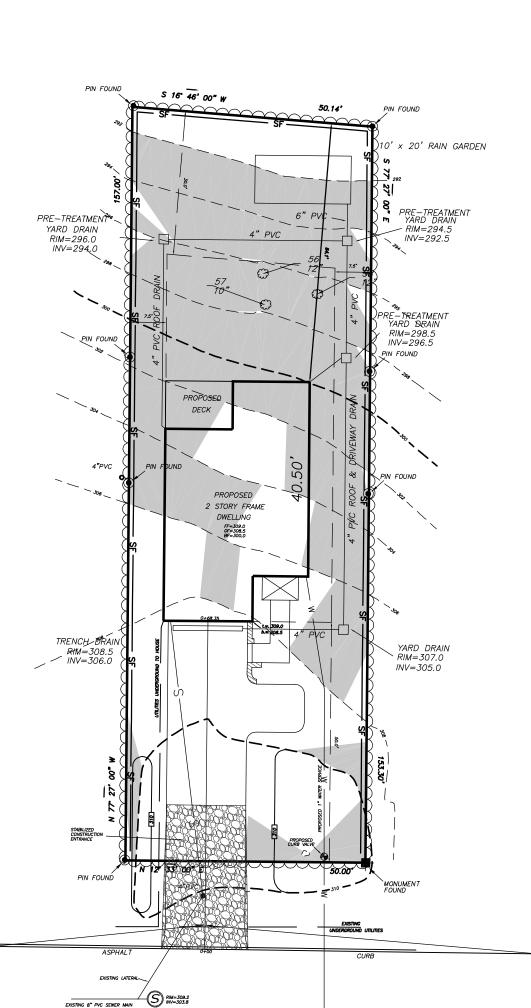

TOWN STEEP SLOPE AND STORMWATER NOTES

1. 259-6H12 Disturbance of existing vegetative ground cover shall not take place more than 15 days prior to grading and construction.

2. 259-6H13 Temporary soil stabilization including if appropriate, temporary stabilization measures such as netting or mulching to secure soil during the grow in period, must be applied to an area of disturbance within 2 days of establishing the final grade, permanent stabilization must be applied with 15 days of establishing the final

3. 259-6H14 Soil stabilization must be applied within 2 days of disturbance if final grade is not expected to be established within sixty days

4.259-6H15 Measures for the control of erosion and sedimentation shall be undertaken consistant with the Westchester County Soil and Water Conservation District's Best Management Practices.

5. 259-6H16 All proposed disturbance of steep slopes shall be undertaken with consider of the soils limitations in the Westchester County Soils survey 6. 259-6H17 Topsoil shall be stripped form all areas of disturbance, stockpiled and stabilized in a manner to

shall not be permitted on slopes of greater than 10% 7. 259-6H18 No organic material or rocks with a size that will not allow appropriate compaction or cover by topsoil shall be used as fill material. Fill material shall be no less granular than the soil upon which it is place

minimize erosion and sedimentation and replace elsewhere on the site at the time of final grading. Stockpiling

8. 259-6H19 Compaction of fill materials in fill areas shall be such to ensure support of the proposed structures and stabilization for intended uses.

TOWN OF CORTLANDT NOTES:

50.14'

x 20' RAIN GARDEN

5 16" 46" 00" W

PROPOSEL

DECK

2 STORY FRAME

DWELLING

FF=309.0 GF=308.5 BF=300.0

EXISTING TOWN WATERMAIN

EAST HILL ROAD

TREE PLAN

SCALE: 1" =20'

PRE-TREATMENT

RIM=296.0

INV=294.0

PIN FOUND

EXISTING 8" PVC SEWER MAIN

_200.0' SIGHT DISTANCE -

Standard erosion and sedimentation control notes.(See Stormwater Pollution Prevention Plan Sequence of Construction notes)

Prior to the start of construction the contractor shall install all erosion and sedimentation control and tree protection as shown on the site plan.

At the completion of construction the owner's Engineer shall submit a certification stating that all work as constructed in compliance to the approved plans on file with the Town and that construction has not adversely affected surface and subsurface drainage of adjacent and adjoining neighbors.

ALL TREES WITHIN 50-FT OF THE PROPOSED LIMITS OF DISTURBANCE SHALL BE TAGGED AND INVENTORIED AND SHOWN ON THE REVISED SITE PLAN BY THE DESIGN PROFESSIONAL. INVENTORIED TREES SHALL BE PLACED IN A SCHEDULE INDICATING THE SIZE AT DBH, TYPE, SCIENTIFIC NAME AND SUB CULTIVARS IF APPLICABLE. STANDARDS FOR RE PLANTING SHALL BE PROVIDED AT TIME OF

CONTACT THE DEPARTMENT OF TECHNICAL SERVICES AT 914-734-1060 AFTER TAGGING TREES TO BE REMOVED FOR INITIAL INSPECTION PRIOR TO REMOVAL OF ANY TRESS.

A REFORESTATION PLAN WILL BE REQUIRED FOR TREES REMOVED FROM THE WETLAND AND WETLAND BUFFER AREA. ENSURE THE PROPOSED PLANTED SPECIES ARE LISTED ON THE "APPROVED SPECIES LIST" OF APPENDIX B TOWN CODE 283 "TREES" AND THAT THE APPROPRIATE QUANTITIES ARE PROPOSED FRO REPLANTING IN ACCORDANCE WITH TOWN CODE 283

PRIOR TO ISSUANCE OF A BUILDING PERMIT, THE APPLICANT SHALL SUBMIT A NOTICE OF INTENT (N.O.I.) TO THE NYSDEC AND PROVIDE PROOF OF COVERAGE UNDER THE SPDES GENERAL PERMIT FOR CONSTRUCTION ACTIVITIES TO THE TOWN OF CORTLANDT.

ANY IMPORTED SOILS SHALL MEET THE NYSDEC STANDARDS OF UNRESTRICTED FILL AND BE SUITABLE FOR RESIDENTIAL USE.
CONSTRUCTION DEBRIS IS NOT PERMITTED TO BE IMPORTED. ANY MATERIAL MEETING THE NYSDEC DEFINITION OF BENEFICIAL USE
SHALL BE CERTIFIED AS SUCH BY HE DESIGN PROFESSIONAL OF RECORD. NOTIFY THE TOWN OF CORTLANDT PRIOR TO IMPORT. SOIL

PRIOR TO THE BACKFILL OF ANY STORM WATER BEST MANAGEMENT PRACTICE, DOTS-ENGINEERING SHALL BE NOTIFIED TO PERFORM AN PRIOR TO THE ISSUANCE OF CERTIFICATION OF OCCUPANCY, THE ENGINEER / ARCHITECT SHALL SUBMIT A CERTIFICATION ADDRESSED TO "THE TOWN OF CORTLANDT DEPARTMENT OF TECHNICAL SERVICES" THAT THE SITE WORK HAS BEEN COMPLETED IN ACCORDANCE WITH THE APPROVED PLANS ON FILE WITH THE TOWN AND THAT THERE IS NO ADVERSE IMPACTS TO ADJACENT AND ADJOINING NEIGHBORS AS IT PERTAINS TO DRAINAGE AND RUNOFF.

PRIOR TO THE ISSUANCE OF A CERTIFICATE OF OCCUPANCY/COMPLIANCE, AN AS-BUILT DETAIL OF ALL RETAINING WALLS SHALL BE THE APPLICANT IS AWARE THAT THE ENTIRE SITE MUST BE 100% STABILIZED PRIOR TO THE ISSUANCE OF A CERTIFICATE OF

PRIOR TO THE ISSUANCE OF A CERTIFICATION OF OCCUPANCY, AN "AS-BUILT" SURVEY PREPARED BY A LICENSED PROFESSIONAL LAND SURVEYOR OF THE PROPERTY SHALL BE SUBMITTED TO THE DEPARTMENT OF TECHNICAL SERVICES. A FEMA 500 YEAR FLOOD PLAIN EXISTS ON THIS PROPERTY.


OCCUPANCY. DISTURBED AREAS SHALL BE RESTORED AND STABILIZED APPROPRIATELY AND IN A TIMELY MANNER. APPLICANT SHALL SUBMIT NOTICE OF TERMINATION FOR THE SPDES GENERAL PERMIT.

NO STEEP SLOPES ARE TO BE CREATED, ALL GRADES SHALL BE MAINTAINED MAX. 4H:1V OR STABILIZED WITH EROSION CONTROL

ANY FILL PROPOSED TO BE IMPORTED MUST BE TESTED IN ACCORDANCE WITH THE TOWN'S SOIL TESTING POLICY PRIOR TO CONSTRUCTION A SURVEYOR SHALL FIELD STAKE THE PROPERTY LINES AND SUBMIT TO THE TOWN A COPY OF THE STAKE OUT SKETCH.

CONTRACTOR IS RESPONSIBLE TO MAINTAIN ALL EROSION CONTROL PRACTICES THROUGHOUT THE DURATION OF CONSTRUCTION DEEP TEST PITS AND SOIL PERCOLATION TESTS SHALL BE CONDUCTED IN THE AREA OF THE PROPOSED STORMWATER PRACTICES. THE TOWN DEPARTMENT OF TECHNICAL SERVICES SHALL BE CONTACTED AT 914-734-1060 TO WITNESS THE TEST. ALL DRAINAGE IMPROVEMENTS ARE IN COMPLIANCE WITH WESTCHESTER COUNTY RULES AND REGULATIONS FOR SEPERATION DISTANCES TO WASTE WATER SERVICES

CONTRACTOR / EXCAVATOR TRAINING CERTIFICATES IS TO BE PROVIDED TO THE TOWN PRIOR TO CONSTRUCTION. NYS CODE 811 DIG SAFELY https://www.sigsafelynewyork.com/cep MUST BE CONTACTED AS REQUIRED IN CODE SECTION 811 A DOUBLE CHECK VALVE SHALL BE INSTALLED TO PROTECT THE PUBLIC WATER SUPPLY. THIS CHECK VALVE SHALL BE INSTALLED IN THE HOUSE PRIOR TO ANY TAPS AND LOCATED IN AN AREA ACCESSIBLE FOR REPAIR OR REPLACEMENT.

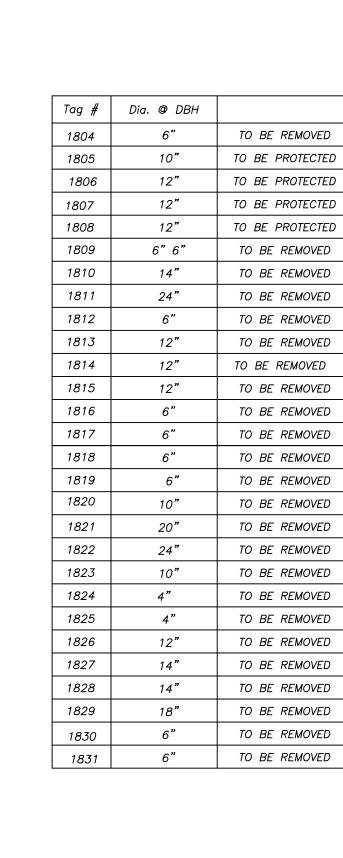

TOPOGRAPHIC SURVEY PREPARED BY LINK LAND SURVEYORS, DATED DECEMBER 19, 2022. DATUM IS NAVD 1988

THERE ARE NO WATERCOURSES. PONDS, LAKES AND WETLANDS WITHIN 200 FEET OF THE PROPERTY LINE EXCEPT AS SHOWN ON THESE PLANS

THERE ARE NO EXISTING OR PROPOSED WELLS OR SEPTIC SYSTEMS WITHIN 200 FEET OF THE PROPERTY LINES EXCEPT AS SHOWN ON THESE PLANS.

ALTERATION OF THIS DRAWING EXCEPT BY A LICENSED P.E. OR ARCHITECT OR LICENSED LAND SURVEYOR IS ILLEGAL. ANY ALTERATION BY A P.E. OR ARCHITECT OR SURVEYOR MUST BE INDICATED AND BEAR HIS SEAL SIGNATURE AND DATE OF ALTERATION.

845-878-7894 phone

LATEST


REVISION:

SHEET No.


S-2

13.10-1-33

845-878-4939 fax jack4911@yahoo.con

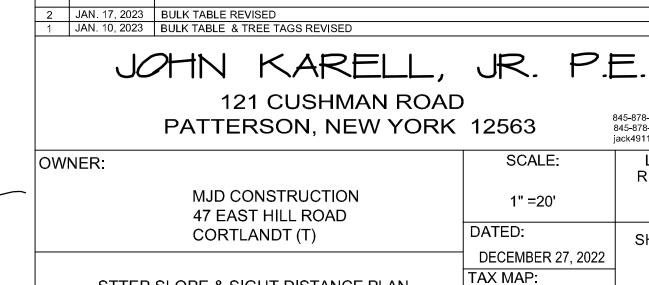



STTEP SLOPE & SIGHT DISTANCE PLAN

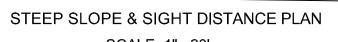


EXISTING TOWN WATERWAIN


EAST HILL ROAD SCALE: 1" =20'

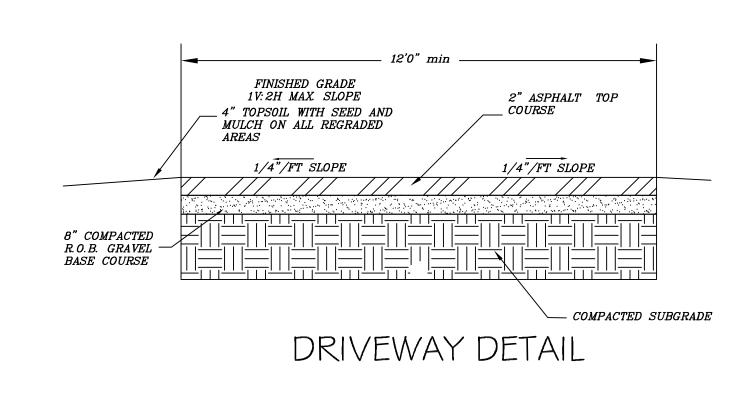

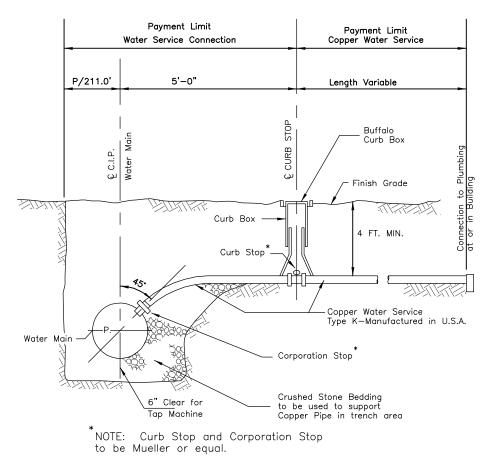


WATER CONNECTION A DOUBLE CHECK VALVE SHALL BE INSTALLED TO PROTECT THE PUBLIC WATER SUPPLY. THIS CHECK VALVE SHALL BE INSTALLED IN THE HOUSE PRIOR TO ANY TAPS.

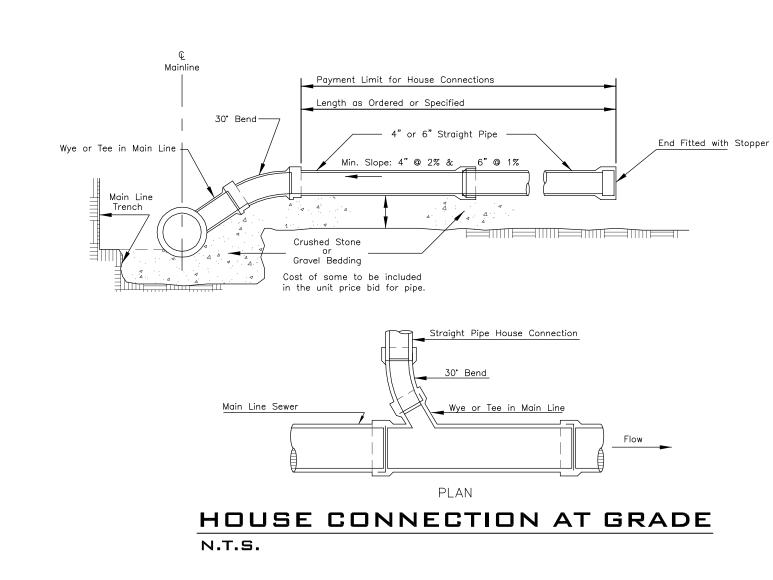

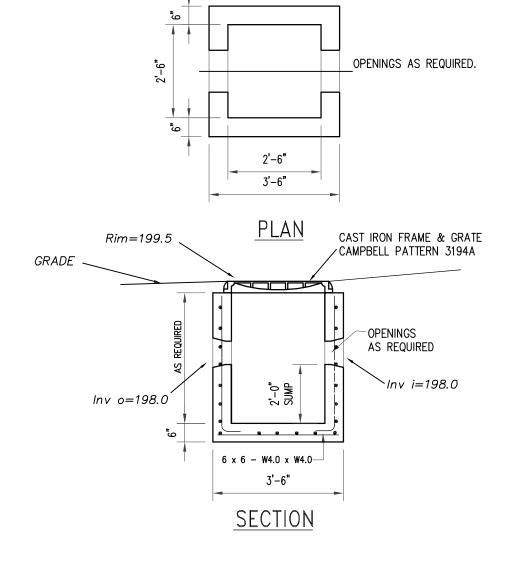

PRETREATMENT YARD DRAIN SCALE N.T.S.

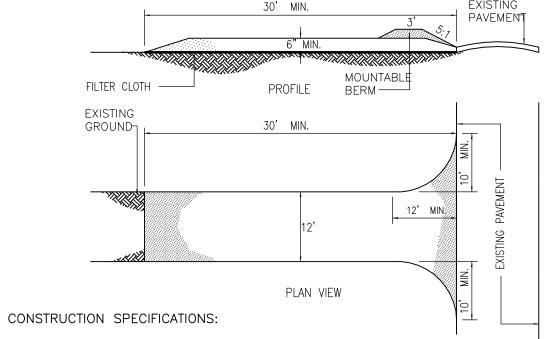


- I. STONE SIZE USE 2" STONE OR RECLAIMED OR RECYCLED CONCRETE EQUIVALENT. 2. LENGTH - NOT LESS THAN 30 FEET.
- 3. THICKNESS NOT LESS THAN SIX (6) INCHES. 4. WIDTH - TWELVE (12) FEET MINIMUM, BUT NOT LESS THAN THE FULL WIDTH AT POINTS WHERE
- 5. FILTER CLOTH WILL BE PLACED OVER THE ENTIRE AREA PRIOR TO PLACING OF STONE.
- 700X, OR APPROVED EQUAL.
- 6. SURFACE WATER ALL SURFACE WATER FLOWING OR DIVERTED TOWARD CONSTRUCTION SHALL BE PIPED ACROSS THE ENTRANCE. IF PIPING IS IMPRACTICAL, A MOUNTABLE BERM WITH
- SLOPES WILL BE PERMITTED.
- 7. MAINTENANCE THE ENTRANCE SHALL BE MAINTAINED IN A CONDITION WHICH WILL PREVENT OR FLOWING OF SEDIMENT ONTO PUBLIC RIGHTS-OF-WAY. ALL SEDIMENT SPILLED, DROPPED
- OR TRACED ONTO PUBLIC RIGHTS- OF-WAY MUST BE REMOVED IMMEDIATELY. 8. WASHING - WHEN WASHING IS REQUIRED, IT SHALL BE DONE ON AN AREA STABILIZED WITH
- WHICH DRAINS INTO AN APPROVED SEDIMENT TRAPPING DEVICE. 9. PERIODIC INSPECTION AND NEEDED MAINTENANCE SHALL BE PROVIDED AFTER EACH RAIN.


STABILIZED CONSTRUCTION ENTRANCE N.T.S.

STOCKPILED AREAS REMAINING FOR MORE THAN I WEEK SHALL -BE SEEDED WITH RYEGRASS 15' MAX FENCE STABLE EXIST. GROUND

TYPICAL SOIL STOCKPILE DETAIL

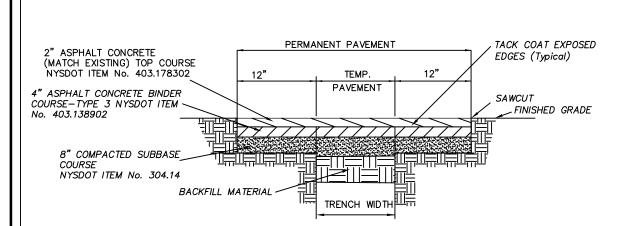

PAVEMENT RESTORATION DETAIL (N.T.S.)

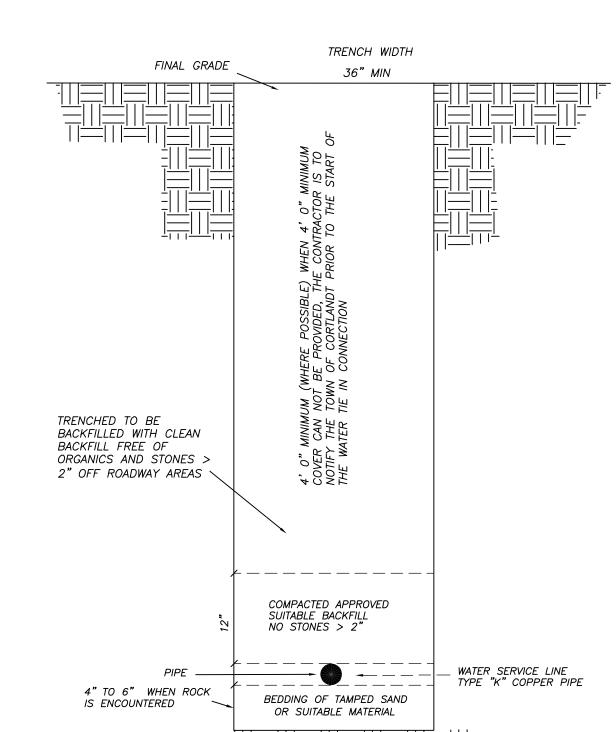

THE CONTRACTOR SHALL CALL IN A "CODE 53" PRIOR TO EXCAVATION FOR THE WATER SERVICE CONNECTION INSTALLATION

NO ROCK IS TO PROJECT WITHIN THE SURFACE OF THE TRENCH AND PIPE SHALL HAVE A MINIMUM CLEARANCE OF 6" TO ALL ROCK 6" BEDDING OF TAMPED SAND SHALL BE USED IN ALL ROCK CONDITIONS

UNSUITABLE MATERIAL EXCAVATED FROM THE TRENCH SHALL NOT N=BE ALLOWED AS BACKFILL AND SHALL BE REPLACED BY SUITABLE MATERIAL APPROVED BY THE ENGINEER SUITABLE MATERIAL SHALL BE AT THE DISCRETION OF THE TOWN OF CORTLANDT SHEETING AND BRACING ARE REQUIRED FOR ALL TRENCHES EXCEEDING 5' IN DEPTH PROVIDE TYPE "K" COOPER WATER SERVICE INDIVIDUAL LINE

THERE SHALL BE A MINIMUM VERTICAL SEPARATION OF 18" FROM ANY STORM OR SANITARY SEWER PIPE TO ANY WATER SERVICE LINE


ALL VALVES, FITTING, METERS AND APPURTENANCES SHALL CONFORM TO AWWA STANDARD C500-87, WCHD, AND THE TOWN REQUIREMENTS.


A MINIMUM 4' COVER SHALL BE PROVIDED OVER ALL WATER LINES THRUST BLOCKS IF ANY, SHALLBE A DIRECTED BY THE TOWN ENGINEER

CLEAN SUITABLE MATERIAL

OR UNDISTURBED EARTH


WATER SERVICE TRENCH DETAIL

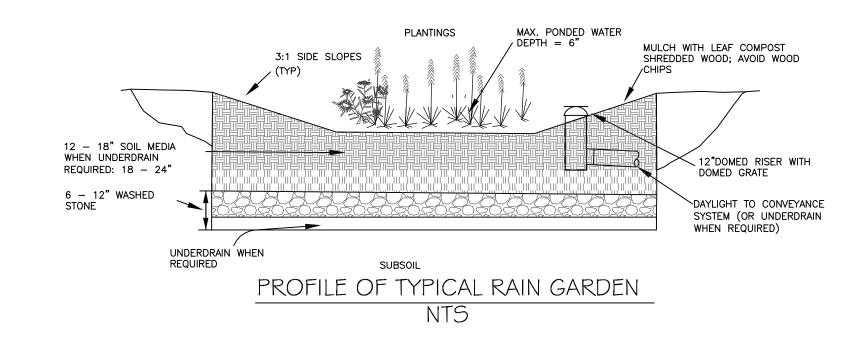

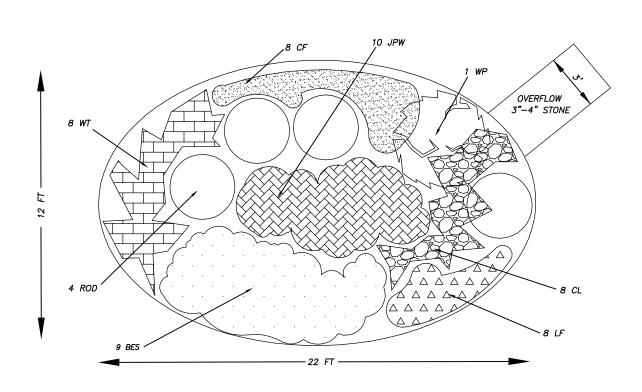

		TYPICAL RAIN GARDEN PLANT LIS	Τ	
QNTY	KEY	BOTANICAL/COMMON NAME	SIZE	ROOT
4	ROD	CORNUS SERICEA (RED-OSIER DOGWOOD)	2 GAL	CONT.
1	WH	HAMAMELIS VIRGINIANA (COMMON WITCHHAZEL)	2'-3' HT.	B&B
8	LF	ATHYRIUM FLIX-FERMINA (LADY FERN)	1 GAL	CONT.
8	WT	CHELONE GLORBRA (WHITE TURTLEHEAD)	1 GAL	CONT.
10	JPW	EUPATORIUM MACULATUM (JOE-PYE WEED)	1 GAL	CONT.
8	CF	OSMUND CINNAMOMEA (CINNAMON FERN)	1 GAL	CONT.
9	BES	RUDBECKIA HIRTA (BLACK-EYED SUSAN)	1 GAL	CONT.
8	CL	VERNONIA NOVEBORGCENSIS (COMMON IRONWEED)	1 GAL	CONT.

RAIN GARDEN MAINTENANCE WEEDING MUST BE PREFORMED FOR THE FIRST FEW YEARS. REMOVE WEEDS, INCLUDING THE ROOTS BY HAND. AFTER EACH GROWING SEASON, THE STEMS AND SEEDHEADS CAN BE LEFT FOR WINTER INTEREST, WILDLIFE COVER AND BIRD FOOD. IN THE SPRING CUT ALL THE PLANTERED PLANTS BACK. HAND CUT THE LARGEST PLANTS. USE A STRING TRIMMER TO MOW THE PLANTING BACK TO A HEIGHT OF SIX OR EIGHT INCHES. DEAD PLANT MATERIAL CAN BE REMOVED WITH A STRING TRIMMER OR WEED WHACKER AND COMPOSTED OR DISPOSED OF AS APPROPRIATE. INVASIVE SPECIES OF PLANTS SUCH AS BITTERSWEET VINE, MULTIFLORA ROSE, HONESUCKLE AND JAPANESE BARBERRY. THESE PLANTS SHOULD BE REMOVED BY VINE SEVERING, MOWING OR USE OF HERBICIDES, (ROUNDUP) WHERE APPROPRIATE AND ACCORDING TO LABEL SECOND FOR THE PROPERTY OF THE PROPER

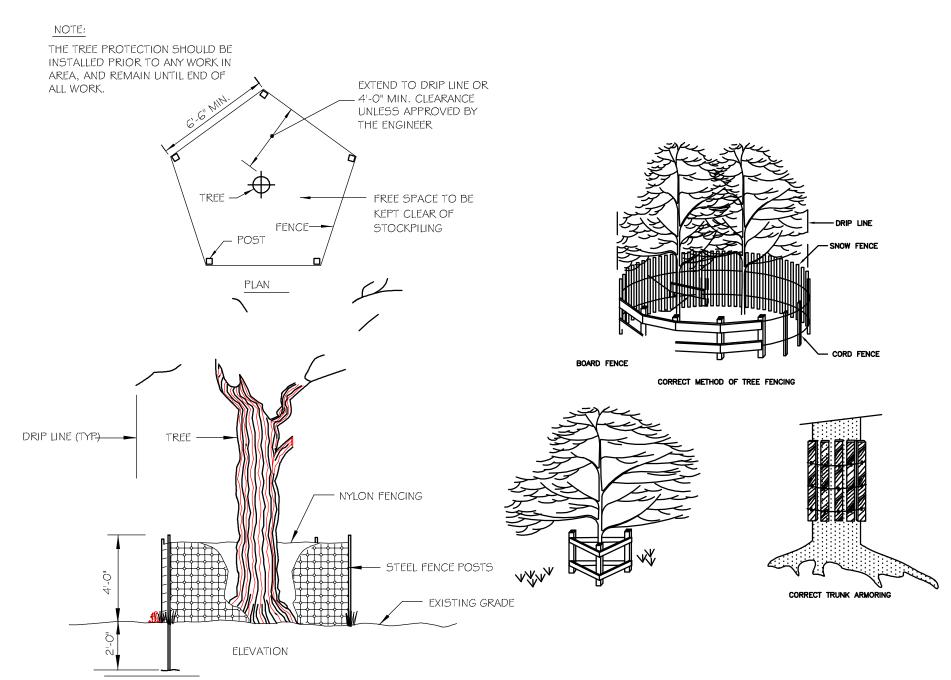


TREE / VEGETATION PROTECTION BARRIER


LINES EXCEPT AS SHOWN ON THESE PLANS.

THERE ARE NO WATERCOURSES. PONDS, LAKES AND WETLANDS WITHIN 200 FEET OF THE PROPERTY LINE EXCEPT AS SHOWN ON THESE PLANS THERE ARE NO EXISTING OR PROPOSED WELLS OR SEPTIC SYSTEMS WITHIN 200 FEET OF THE PROPERTY

ALTERATION OF THIS DRAWING EXCEPT BY A LICENSED P.E. OR ARCHITECT OR LICENSED LAND SURVEYOR IS ILLEGAL. ANY ALTERATION BY A P.E. OR ARCHITECT OR SURVEYOR MUST BE INDICATED AND BEAR HIS SEAL SIGNATURE AND DATE OF ALTERATION.

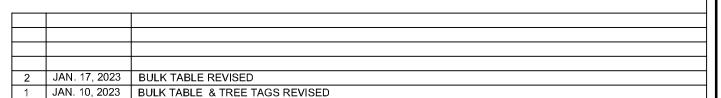



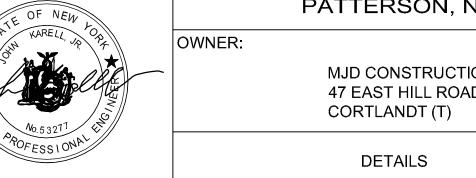

	1	ack4911@yanoo.com
:	SCALE:	LATEST REVISION:
MJD CONSTRUCTION 47 EAST HILL ROAD	1" =40'	
CORTLANDT (T)	DATED:	SHEET No.
	DECEMBER 27, 2022	
DETAILS	TAX MAP:	D-1
	13.10-1-33	